



TAL-CO SUPPLEMENTAL INSTRUCTION #01			
Project Name:	RW TOMLINSON - NEW HEAD OFFICE		
Project Location:	100 Nortel Drive, Ottawa, Ontario		
ARCH. SI #:	N/A	Issued By:	Chris Simpson
STRUC. SI #:	SSI #1	Date Issued:	September 23, 2016
MECH. SI #:	N/A	Revision #:	N/A
ELEC. SI #:	N/A	Revision Date:	N/A

Supplemental Instructions are issued by the Construction Manager to record a clarification or revision to the previously issued Contact Documentation as reflected by the attached information prepared by the identified Professionals.

The Construction Manager shall review the Supplemental Instruction and the attached information and issue to the affected Trade Contractors identifying the following course of action by the Trade Contractor.

Notify Tal-Co within 5 days of receipt, if the attached documents will require a change to Contract Price or Schedule.

**Title:** Modification to concrete upstand at second floor slab level Grid D to E, below Grid 4

**Reference:** Structural and Architectural Drawings

**Attachments:** Structural Site Instruction #1

**Description of the Work:** Addition of Schoeck Isokorb Product at thermal break.

**Reason:** Reduce thermal bridging as per OBC

# STRUCTURAL SITE INSTRUCTION



Cleland Jardine Engineering Ltd., 580 Terry Fox Drive, Suite 200, Kanata, Ontario, K2L 4B9, FAX (613) 591-1703, Tel. (613) 591-1533

TO: TALCO Building Innovations DATE: August 30, 2016

ATTENTION: Chris Simpson EMAIL: csimpson@tal-co.com

PROJECT: Tomlinson – New Building PROJECT No.: 15-0179

ISSUED BY: Brian Johnson, P. Eng. BDS PAGES (Incl this one): 2

STRUCTURAL SITE INSTRUCTION No.: 001

**Affected Drawings:** S101



**References:** Contractor's RFI – Schoek Bar Supplier Question

**Information to be Clarified:** Upstand Support West of Grid 4 between D & E

Provide the Schoek bar connectors for the concrete upstand as noted on the partial plan in SSI-S1-SK1.

**NOTE#1:**

This information was provided to the sub-contractor for pricing purposes in an email previous to this instruction being issued.

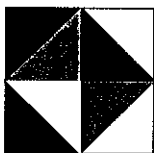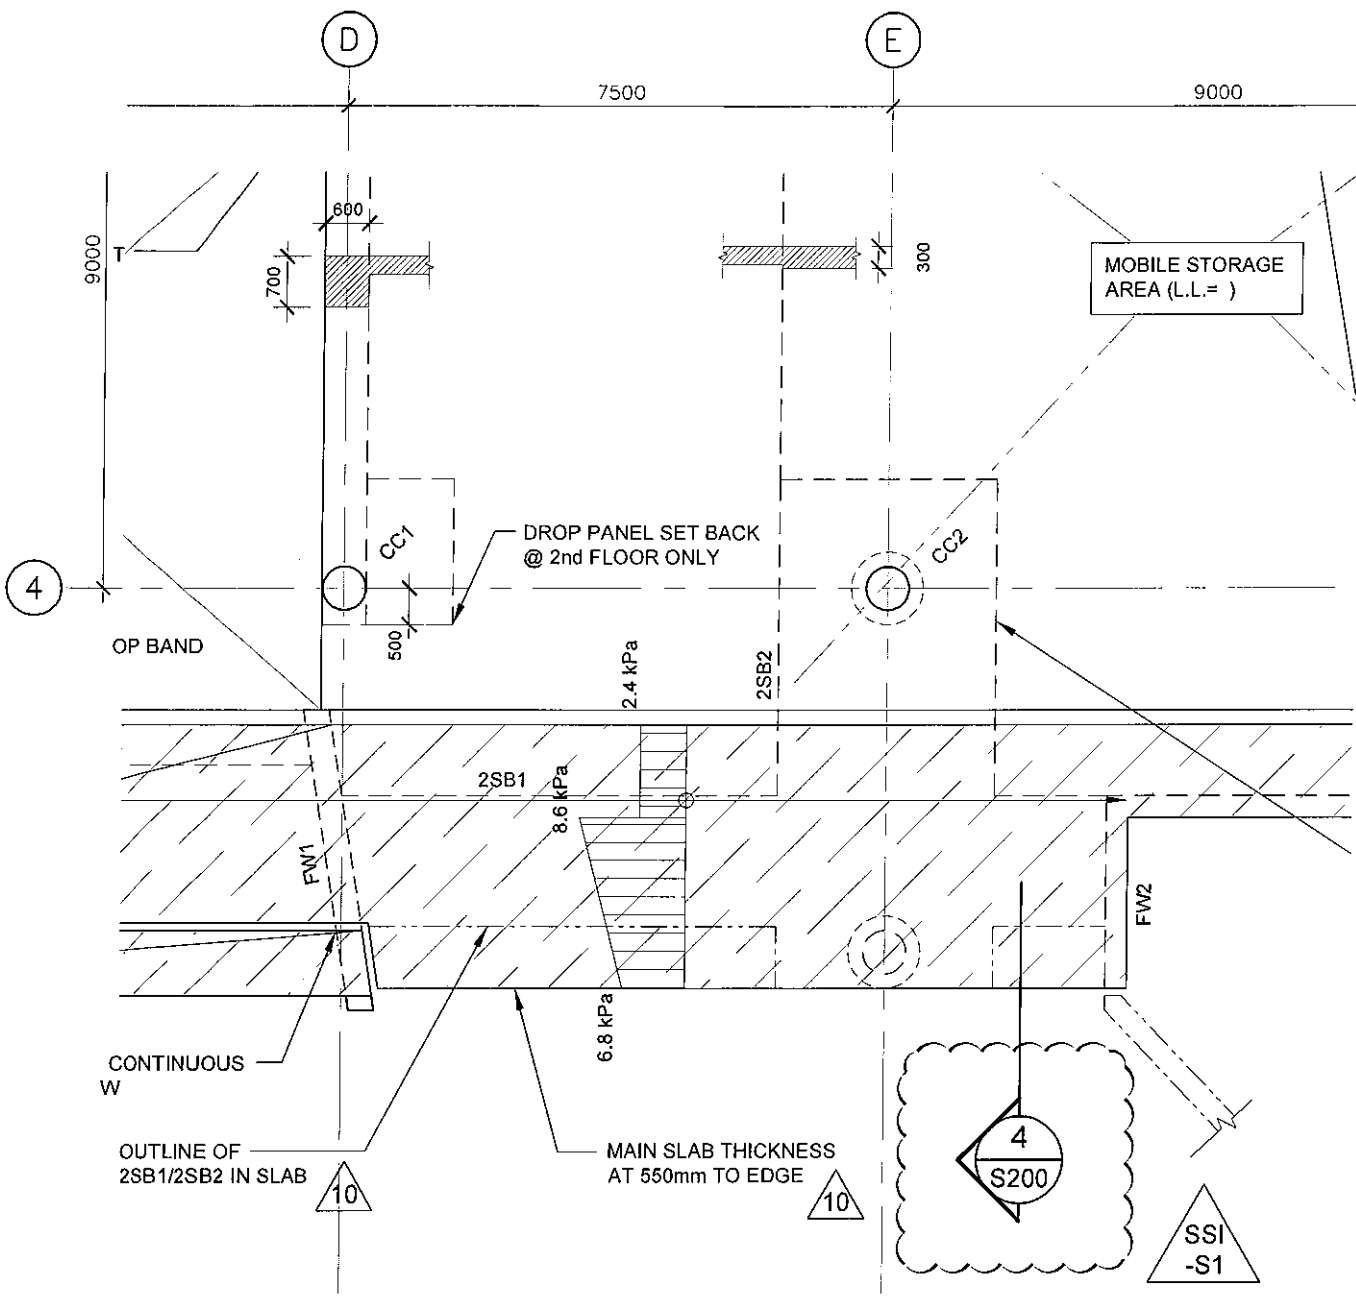

**CLELAND  
JARDINE**  
ENGINEERING LTD

200-580 TERRY FOX DR.  
KANATA, ON K2L 4R9  
(613) 591-1533

PROJECT  
**TOMLINSON NEW BUILDING**

DRAWING  
**PARTIAL SECOND FLOOR PLAN**

DRAWN: S. HAGEN  
DESIGNED: B. JOHNSON  
DATE: AUG 30/16  
SCALE: N.T.S.  
PROJECT No: 15-0179

DRAWING No.

**SSI-S1  
SK1**